



NOTES TO G.C.

- 1. Give special attention to any obstructions to ceiling pockets & cables (i.e. ducts, sprinkler pipes, drain pipes, electrical conduits, etc.).
- 2. One steel C-channel^{**} (flanges down) to be supplied & installed by others. Alternate steel support to be approved by Skyfold.

**C-channel designation:

North & South America = C8 x 11.5 [C200 x 17] Europe = C200 x 75 Asia = C200 x 80

Support steel above the wall along its axis must be parallel to the floor within $\frac{1}{2}$ [12.7] for the entire length of the wall (this includes loaded deflection).

- 3. Attachment details of C-channel** to structure to be designed by others & must not interfere with Skyfold hangers or motor unit or lifting cables.
- 4. Structural steel support & bracing must not interfere with motor mounts or ceiling supports.
- 5. Sprayed-on fireproofing (mineral wool & cement) is not recommended for use on the steel support to which Skyfold is attached. An intumescent coating or film is preferred. Local building codes must be respected. Fireproofing is by others.
- 6. Approximate weight of wall: XXXX lbs. [XXXX Kg.] Maximum weight per hanger: XXX lbs. [XXXX Kg.]
- 7. Maximum cable tension: XXX lbs. [XXX N.]

8. Specified electrical: 208 VAC, 3Ø, 60 Hz.

THE ELECTRICAL CONTROL BOX IS TO BE MOUNTED BY THE ELECTRICAL CONTRACTOR.

* POWER MUST BE AVAILABLE AT TIME OF INSTALLATION.

- 9. 24 volt key switch controls & boxes to be installed by electrical contractor as per standard light switch. Boxes to be fitted at desired key switch location with suitable cable run back through ceiling void to control box position, including sufficient spare to allow connection. Key switches are supplied by Skyfold & are required on each side of the wall.
- 10. Motor size: Varies - project-specific. Full load amp: XXXX A
- 11. Skyfold requires two 24" x 24" [610 x 610] (minimum) access panels in acoustic ceiling directly beside motor for installation & maintenance of system. Not required if finished ceiling is suspended ceiling tiles.
- 12. Drive unit to be installed prior to construction of acoustic barrier & pocket. All pocket construction (gypsum, suspended ceiling tile, framing, etc.) is by others.
- 13. Do not scale from this drawing. All dimensions must be verified on site.
- 14. Dimensions in [] are in millimeters (mm) unless noted otherwise.
- <u>LEGEND</u>
- KEY SWITCH CONTROL

CEILING SUPPORT & HANGER

CEILING ACCESS PANEL

NOTE: SEE DRAWINGS R811737 & R811738 FOR 11'10" MINIMUM TO 17'-0" MAXIMUM [3605 MINIMUM TO 5180 MAXIMUM] LONG WALL CONDITIONS.

– Pocket framing must not interfere with motor unit & must allow for

easy access via access panels.

- Electrical control box can be located

– Access panel to motor unit,

2 locations (see note #11).

24" x 24" [610 x 610] minimum,

14" [355], Do not locate any switches, alarms, thermostats, door frames, etc.

Do not locate Skyfold switch within this

(either side of wall) must be recessed

(flush-mounted) into the fixed wall.

area. Any other switch, alarm, thermostat, door frame, etc. located within this area

within 15'-0" [4575] of its indicated position.

within this area.

SEE DRAWINGS \$1419 & \$1420 FOR 24'-0" MINIMUM TO 36'-0" MAXIMUM [7315 MINIMUM TO 10973 MAXIMUM] LONG WALL CONDITIONS.

THIS DRAWING IS IN INTENDED AS A GUIDE. IN ALL CASES SKYFOLD SHOP DRAWINGS SPECIFIC TO EACH PROJECT ARE REQUIRED FOR FINAL BUILD-TO DIMENSIONS.

TYPICAL SKYFOLD WALL

17'-0" min to 24'-0" max [5180 min to 7315 max] x 9'-0" max [2745 max] B.O. Pocket Micro drive unit

PLAN & MECHANICAL DETAILS

Contractor

Approved by

Date

Sheet No. 1 of 3

Revision

9

Drawn by

Scale As noted

Drawing No. R811826

Skyfold project No.

Drawing title


Architect

Authorized Skyfold distributor

NOTE:

SEE DRAWINGS R811826 & R811827 FOR 17'-0" MINIMUM TO 24'-0" MAXIMUM [5180 MINIMUM TO 7315 MAXIMUM] LONG WALL CONDITIONS.

SEE DRAWINGS \$1419 & \$1420 FOR 24'-0" MINIMUM TO 36'-0" MAXIMUM [7315 MINIMUM TO 10973 MAXIMUM] LONG WALL CONDITIONS.

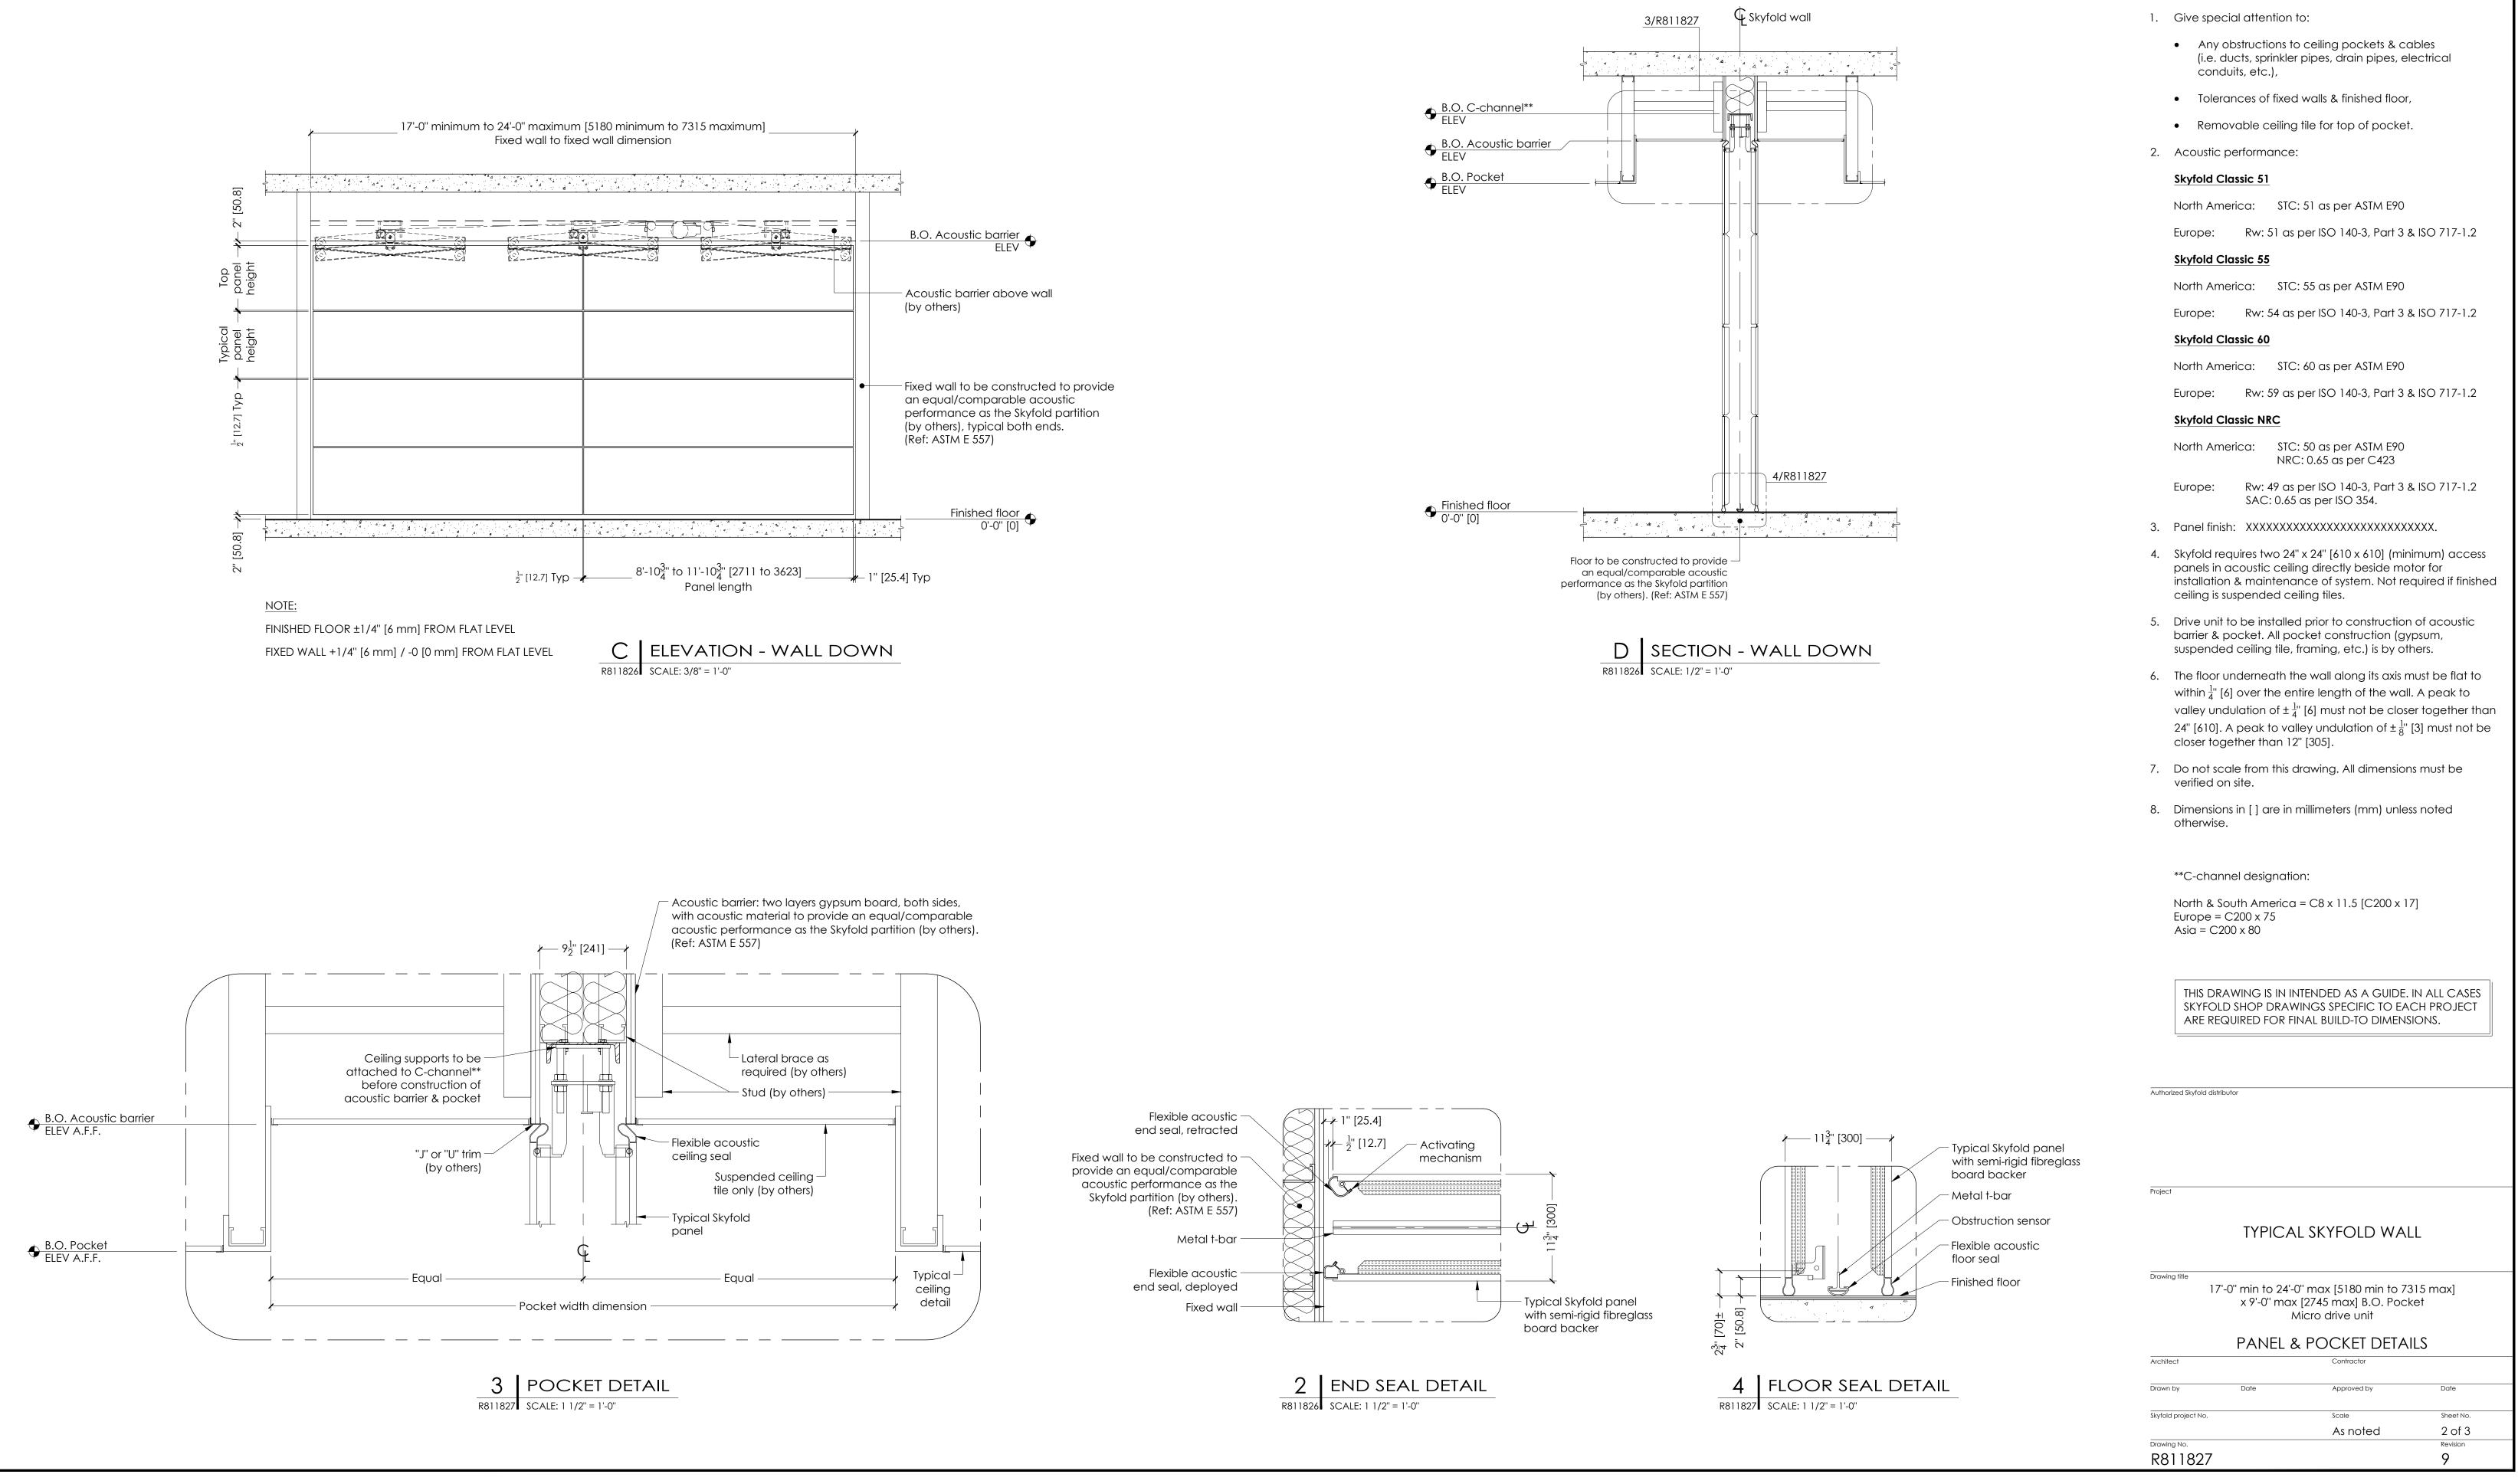



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